


CITY OF LOS ANGELES
PLAN AND PROFILE
PUMPING SYSTEM
SEC. I - VENICE OUTFALL SEWER
LA City Bureau of Engineering Document
D-1589-1 1928

Original
Siphon Start Under
Ballona Creek
Alluvium,
Pre-Channelization


Venice Outfall Sewer & Siphon

JOHN C. SHAW, CITY ENGINEER
Approved April 7th, 1928
John C. Shaw
City Engineer

Del Rey
Company
Del Rey Company, Inc.
1119-23
L.A.C.F.C.D.
Del Rey Company, Inc.
April, 1928

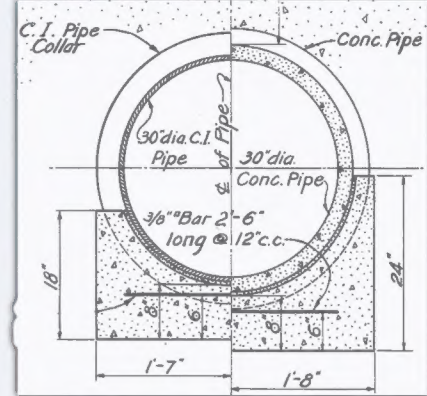

Cast Iron -> Concrete

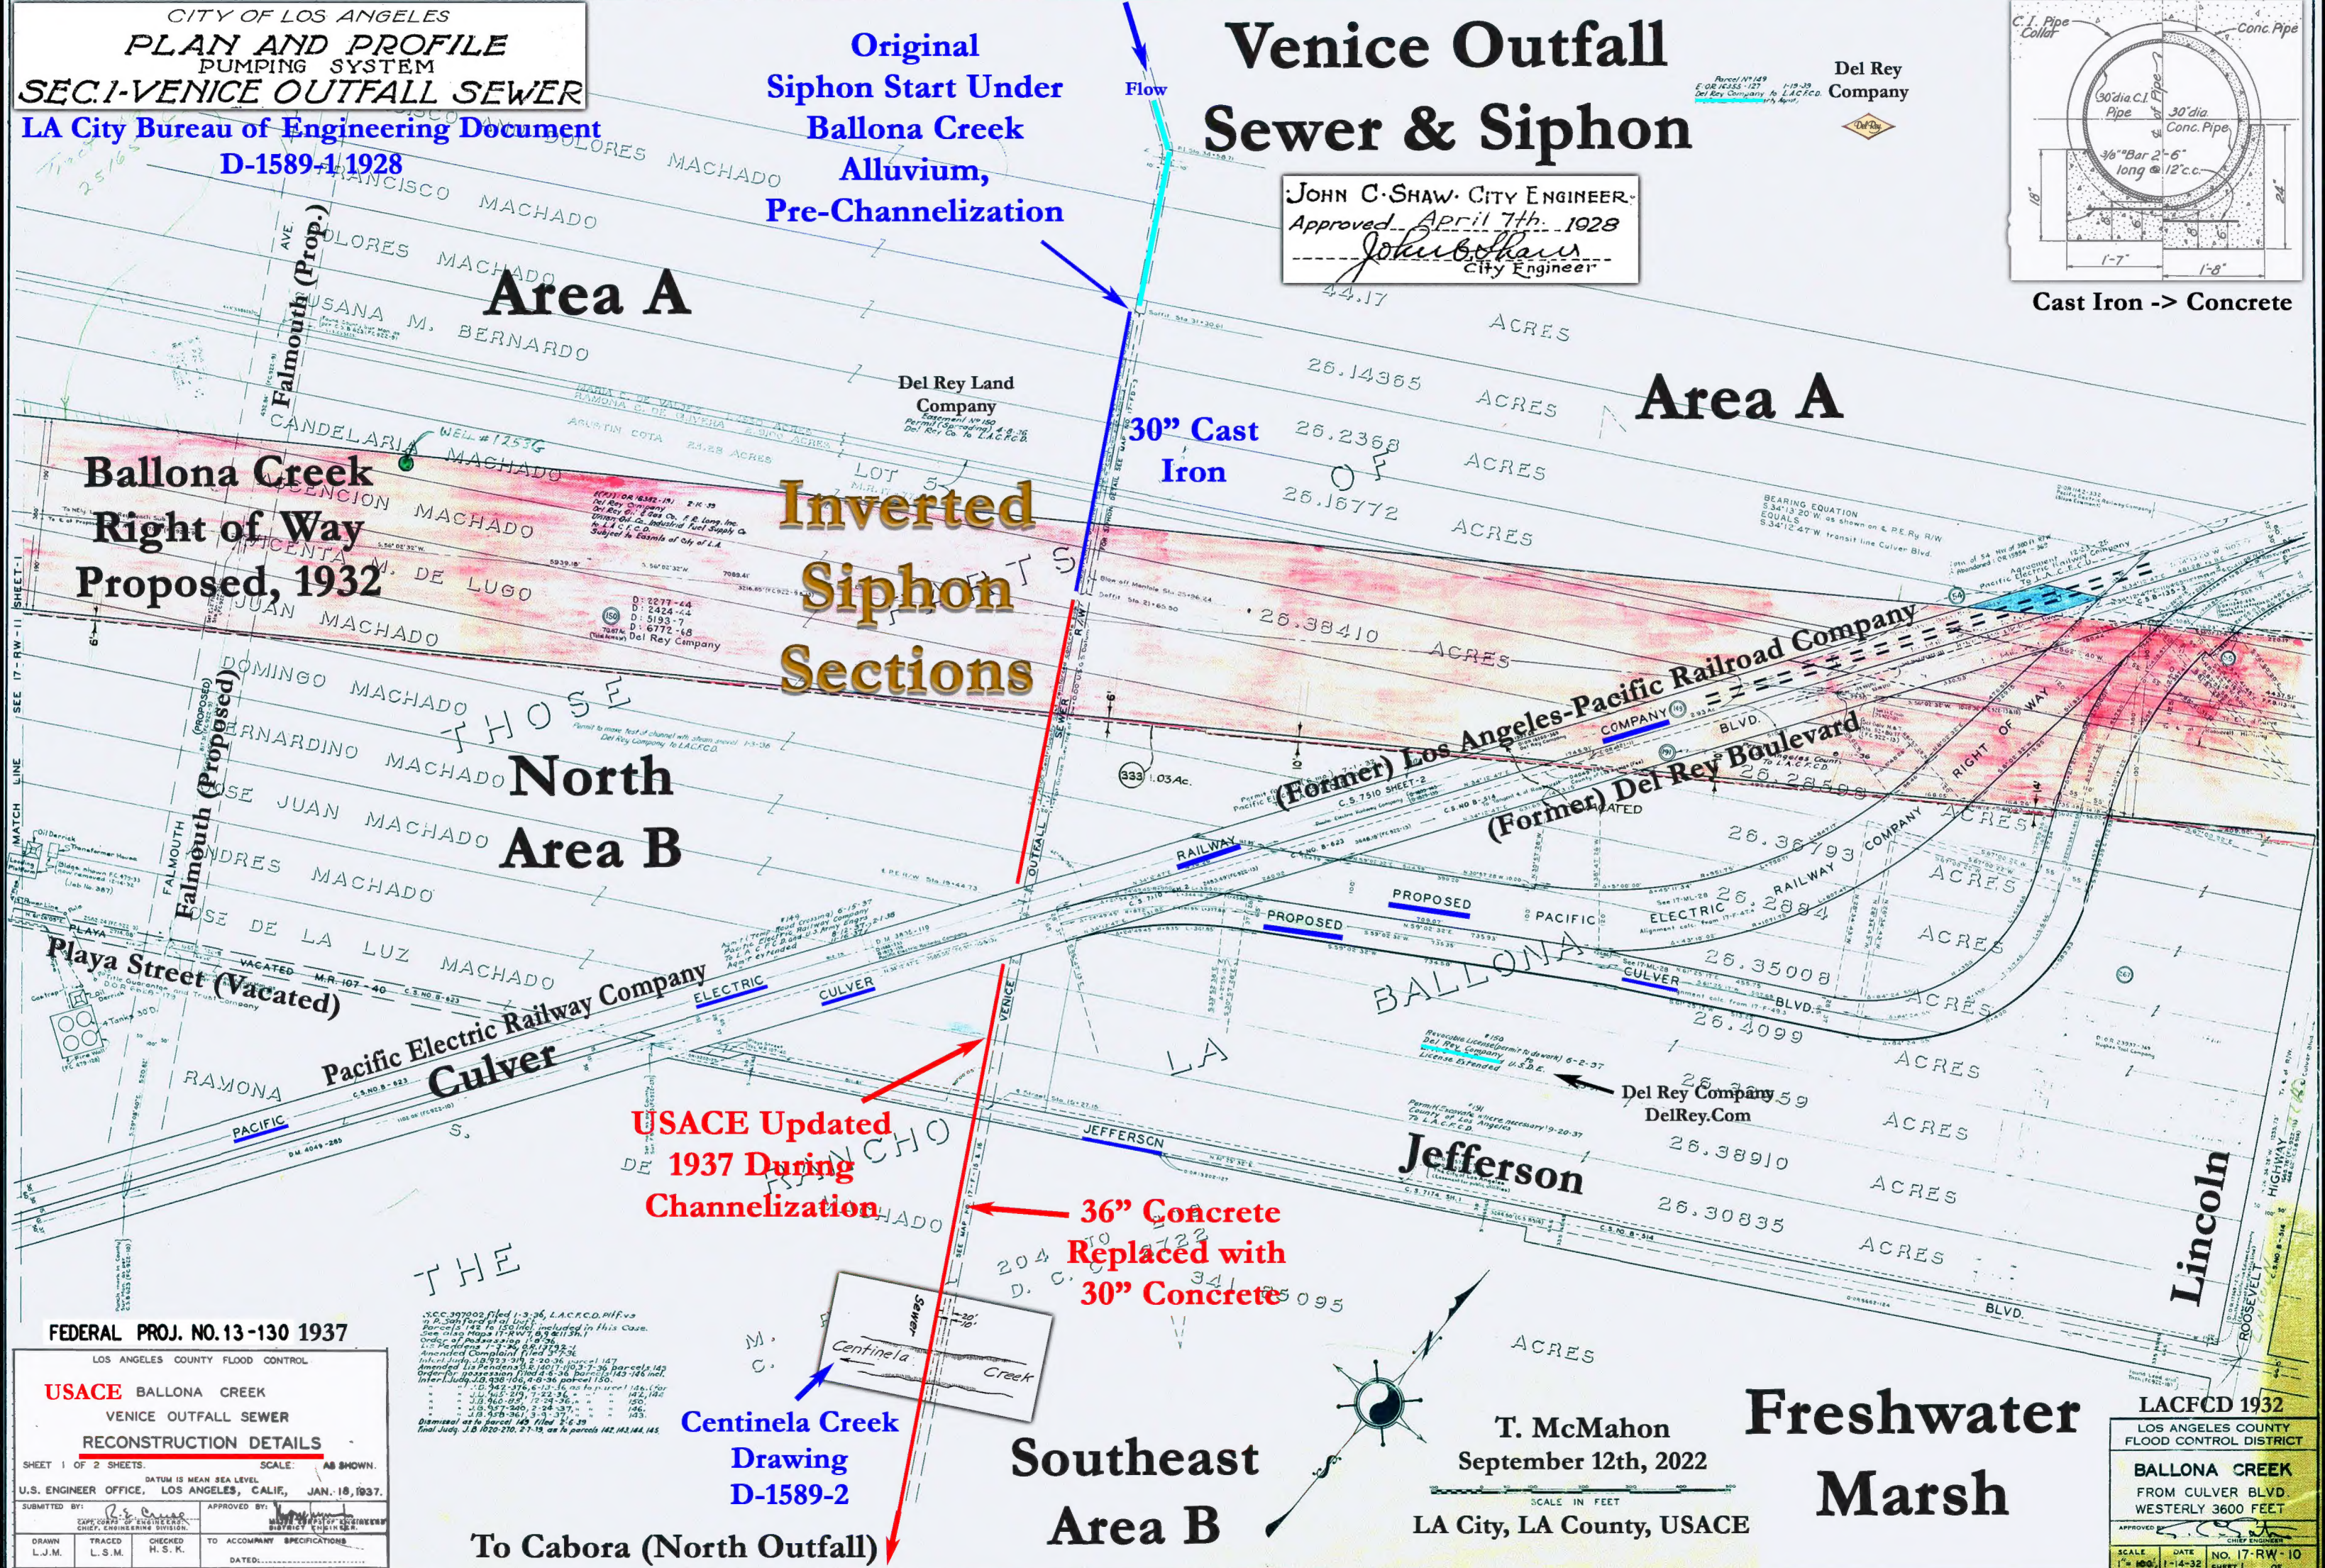

FEDERAL PROJ. NO. 13-130 1937
LOS ANGELES COUNTY FLOOD CONTROL
USACE BALLONA CREEK
VENICE OUTFALL SEWER
RECONSTRUCTION DETAILS
SHEET 1 OF 2 SHEETS
SCALE: AS SHOWN
DATUM IS MEAN SEA LEVEL
U.S. ENGINEER OFFICE, LOS ANGELES, CALIF., JAN. 18, 1937
SUBMITTED BY: R. S. Shaw
APPROVED BY: J. C. Shaw
DRAWN: L. J. M.
TRACED: L. S. M.
CHECKED: H. S. K.
TO ACCOMPANY SPECIFICATIONS
DATED:

LACFCD 1932
LOS ANGELES COUNTY
FLOOD CONTROL DISTRICT
BALLONA CREEK
FROM CULVER BLVD.
WESTERLY 3600 FEET
APPROVED BY: J. C. Shaw
SCALE: 1" = 100'
DATE: 1-14-32
SHEET 1 OF 2